



SPECIES		QUANTITY	MIN. HEIGHT TO BE PLANTED (cm)	MAINTENANCE	BIODIVERSITY
C Tn	Choisya Ternata 'Mexican Orange Blossom'	1	30	Propagate by semi-hardwood cuttings. Prune out any diseased, damaged or dead shoots and thin out crowded shoots. After pruning, plants benefit from mulching and feeding.	Bees Butterflies
Pi te	Pittosporum tenuifolium 'Sllver Queen' (f/v) tawhiwhi 'Silver queen'	1	40	Propagate by semi-hardwood cuttings in Summer. No routine pruning necessary. Remove diseased, damaged, congested or crossing shoots. After pruning, mulch and feed.	
Fa Ja V.	Fatsia japonica 'Variegata' Japanese aralia 'Variegata'	1	30	Propagate by semi-hardwood cuttings. Prune out any diseased, damaged or dead shoots and thin out crowded shoots. After pruning, plants benefit from mulching and feeding.	
Ph c	Phormium cookianum subsp. hookeri 'Cream delight' (v)	2	20	Propagate by division in spring. Dead or damaged leaves may be removed in the spring.	Bees Butterflies and other pollinating insects
Euf	Euonymus fortunei 'Emerald Gaiety' (V) spindle 'Emerald Gaiety'	1	20	Propagate by semi-hardwood cuttings. Prune out any diseased, damaged or dead shoots and thin out crowded shoots. After pruning, plants benefit from mulching and feeding.	Bees and other pollinating insects
(H)	Laurel Hedge Prunus Laurocerasus	4	50	Propagate by semi-ripe cuttings from late summer to autumn.Prune out any diseased, damaged or dead shoots and thin out crowded shoots. After pruning, mulch and feed.	Birds and other nesting wildlife
L N.	Lonicera nitida	3	50	Propagate by semi-ripe cuttings from late spring to late summer. Clip any time from spring to autumn.	Birds Insects
Phf	Photinia x fraseri 'Red Robin'	2	50	Propagate by semi-hardwood cuttings in Summer. No routine pruning necessary, Remove diseased, damaged, congested or crossing shoots. After pruning, mulch and feed.	Birds
(C)	Compact Laurel 'Otto Luyken'	2	50	Propagate by semi-ripe cuttings from late summer to autumn.Prune out any diseased, damaged or dead shoots and thin out crowded shoots. After pruning, mulch and feed.	Birds and other nesting wildlife

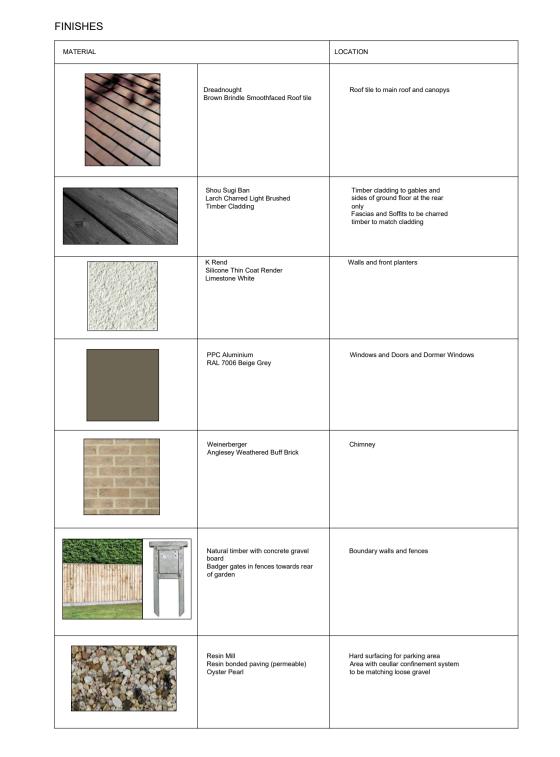








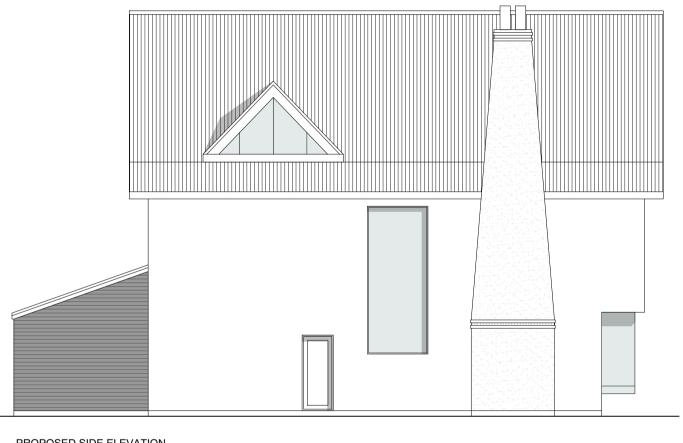




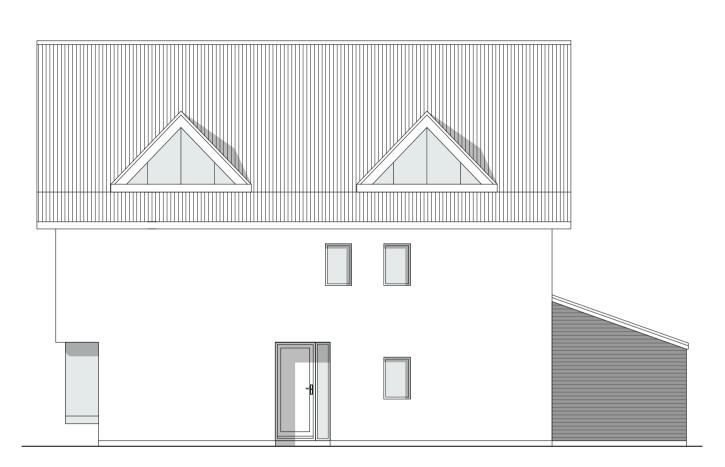

PROPOSED SIDE ELEVATION





PROPOSED REAR ELEVATION

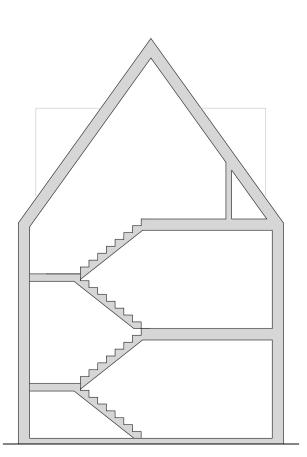


PROPOSED SECTION - 1:100



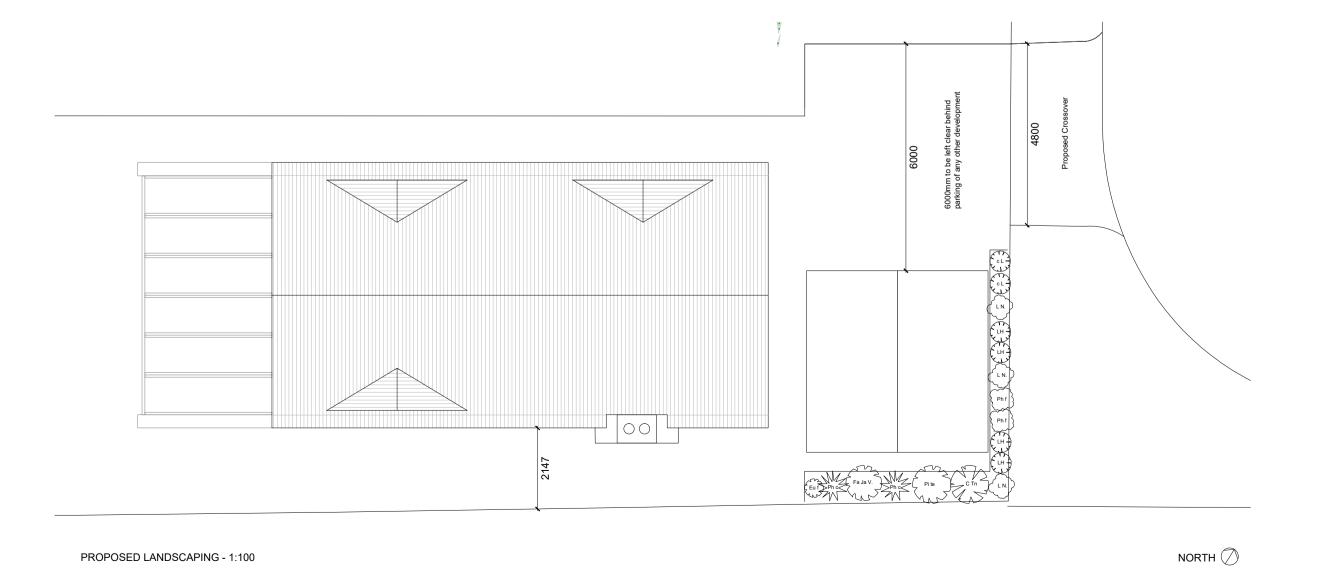

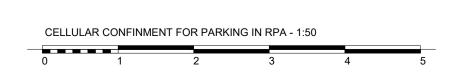

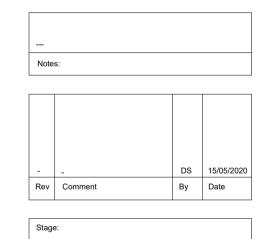

Stage:
3 - Developed Design
Client:
Mr G Newton
Project:
Hayden House
10 Underwood Square
Leigh - on - sea
SS9 3PB

Drawing Title:	
Proposed	
Drawing no:	Revision:

Drawing no: 385-P801	Revision:
Project no: 385	Drawn by: DS, MRS
Scale: 1:50, 1:100 @ A1	Chkd by: SK

## SKARCHITECTS

853-855 London Road Westcliff-on-Sea SS0 9SZ Tel: 01702 509250 Email: info@skarchitects.co.uk